



DRAWING LEGEND		
SHEET	DWG/SHT	DRAWING TITLE
1		ELEVATIONS AND DESIGN CRITERIA
	1.1	END ELEVATION @ CONCESSION WINDOW
	2.1	MENS SIDE ELEVATION
	3.1	END ELEVATION
		DRAWING LEGEND
		DESIGN CRITERIA
		GENERAL NOTES
		WOOD
		THERMAL AND MOISTURE PROTECTION
		EXTERIOR FINISHES
2		PLAN VIEW, GENERAL NOTES AND SCHEDULES
	1.2	PLAN VIEW
	2.2	DOOR ELEVATIONS
		DOOR SCHEDULE
		ROOM FINISH SCHEDULE
		RESTROOM INTERIOR FINISHES
		CHASE/UTILITY INTERIOR FINISHES
		INTERIOR SPECIALTIES
3		FRAMING DETAILS AND SECTIONS
	1.3	PRIVACY SCREEN WITH TRELLIS DETAIL
	2.3	CORNER AND TEE DETAILS
	3.3	HEADER DETAIL
	4.3	SECTION VIEW
	5.3	HVAC ROUGH OPENING DETAIL
	6.3	SECTION DETAIL @ EXTERIOR WALL
	7.3	SECTION DETAIL @ RIGDE BEAM AND CHASE WALL
	8.3	SECTION VIEW @ RIGDE SUPPORT COLLAR TIE
		GENERAL NOTES
4		ROOF FRAMING & SECOND FLOOR DETAILS
	1.4	FLOOR FRAMING PLAN SECOND FLOOR
	2.4	CEILING FRAMING PLAN SECOND FLOOR
	3.4	ROOF FRAMING PLAN SECOND FLOOR
	4.4	ROOF FRAMING PLAN FIRST FLOOR
	5.4	SECOND FLOOR SECTION DETAIL
5		METAL ROOF AND METAL ROOF DETAILS
	1.5	VENTED RIDGE
	2.5	EAVE FLASHING
	3.5	RAKE FLASHING
	4.5	WALL TO ROOF FLASHING
	5.5	EAVE FLASHING
	6.5	STAIRWAY SECTION
6		ROOF FRAMING AND STEEL FRAMING PLAN
	1.6	STEEL FLOOR FRAMING PLAN
	2.6	FLOOR FRAME ELEVATION
	3.6	PLAN VIEW @ ELECTRIC CHASE E1
	4.6	SECTION DETAIL @ ELECTRIC CHASE E1
	5.6	FLOOR FRAMING DETAILS
		GENERAL CONCRETE NOTES
7		FOUNDATION DETAILS
	1.7	FOUNDATION PLAN USING PIERS
	2.7	PLAN VIEW @ PIER P2
	3.7	SECTION DETAIL @ PIER P2
	4.7	CONNECTION DETAIL @ FOUNDATION
	5.7	PLAN VIEW @ PIER P1
	6.7	SECTION DETAIL @ PIER P1
	7.7	UTILITY OPENING LOCATIONS
	8.7	CONNECTION DETAIL @ FOUNDATIONS
		GENERAL CONCRETE NOTES FOR SITE POURED CONCRETE
8		PLUMBING DETAILS & SCHEDULES
	1.8	FIXTURE PLAN
	2.8	FIXTURE ELEVATIONS
9		DRAIN, WASTE & VENT
	1.9	DRAIN, WASTE, & VENT PLAN
		GENERAL PLUMBING NOTES
10		WATER RISER PLANS
	1.10	HOT WATER SUPPLY PLAN
	2.10	COLD WATER SUPPLY PLAN
11		ELECTRICAL PLAN AND SCHEDULES
	1.11	FIRST FLOOR ELECTRICAL PLAN
	2.11	SECOND FLOOR ELECTRICAL PLAN
	3.11	ELECTRICAL PANEL ASSEMBLY
		ELECTRICAL FIXTURE SCHEDULE
		CONDUIT & WIRING NOTES
		LIGHTING CONTROL NOTES:
		MECHANICAL NOTES
		GENERAL ELECTRICAL NOTES
		PANEL "A" LAYOUT
		PANEL "B" LAYOUT
12		FASTENING SCHEDULE AND SITE WORK
	1.12	HANDLING PROCEDURES DOUBLEWIDE
	2.12	HANDLING PROCEDURES SECOND FLOOR
		SITE WORK LEGEND
		OFFLOADING AND SETTING OF THE BUILDING
		UTILITY HOOKUPS
		ANCHORING OF THE RESTROOM
		BUILDING STARTUP STEPS
		FASTENING SCHEDULE

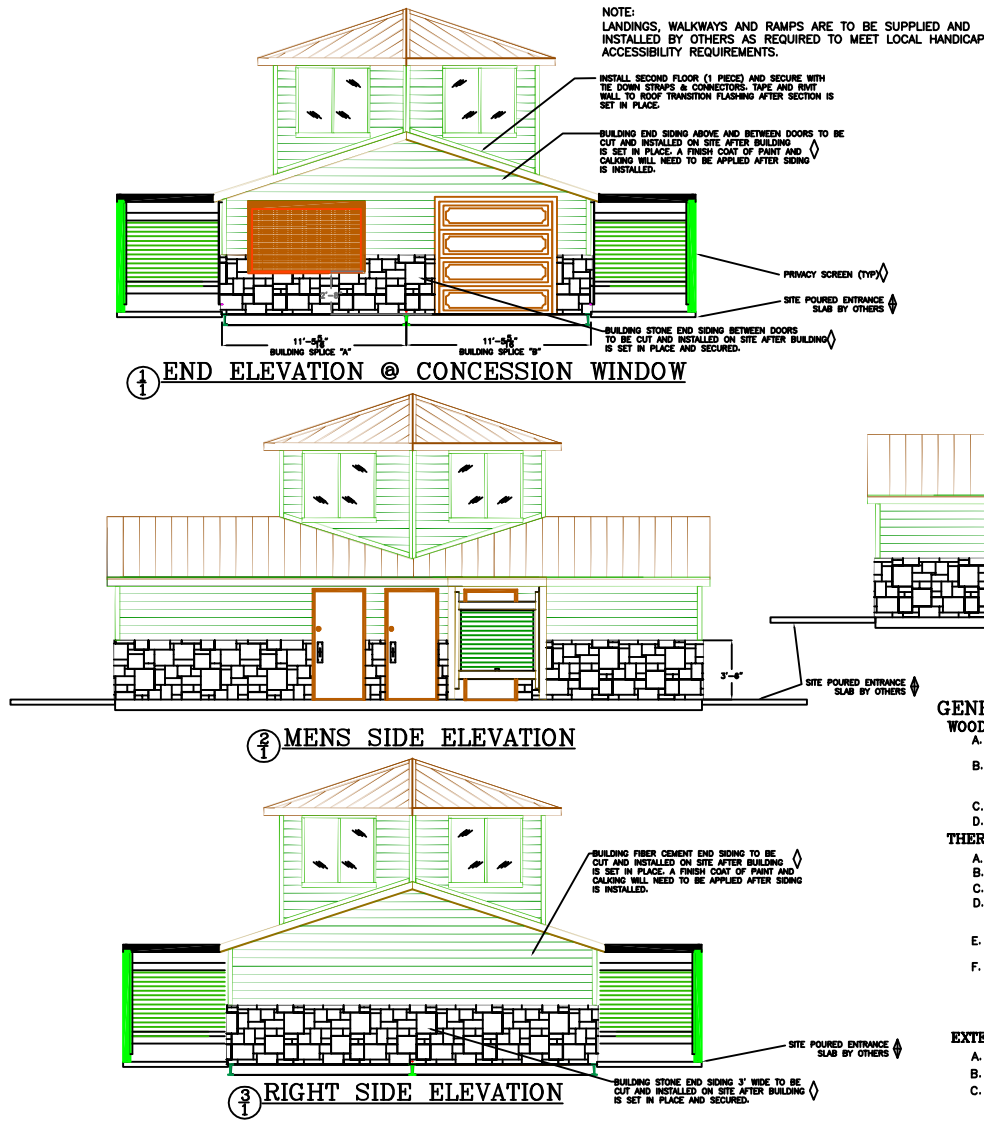

DESIGN CRITERIA	
CODE REFERENCE:	
2000 IBC CODE W/2003 KENTUCKY BUILDING CODE & AMENDMENTS, July 27, 2005.	
2005 NATIONAL ELECTRICAL CODE WITH KBC AMENDMENTS	
2003 KENTUCKY STATE PLUMBING CODE KBC AMENDMENTS	
2000 INTERNATIONAL MECHANICAL CODE KBC AMENDMENTS	
2003 INTERNATIONAL ENERGY CODE KBC AMENDMENTS	
NFPA 1 - UNIFORM FIRE CODE	
HANDICAP CODE REFERENCE	
2003 KBC SUPPLEMENT-Amends Chapter 11 based on ADAAG	
CONSTRUCTION TYPE: V-B	SNOW LOAD: 20 P.S.F.
STORIES: 2	BASIC WIND LOAD: 90 M.P.H.
OCCUPANCY CLASSIFICATION: B	WIND EXPOSURE: C
BUILDING AREA: 835 SQ.FT	FLOOR LIVE LOAD: 50 P.S.F.
OCCUPANCY LOAD: 9	SEISMIC ZONE: Av < .15, Aa <<.15
Uo WALLS: .088	SEISMIC HAZARD EXPOSURE GROUP: I
Uo ROOF/ CEILING: .048	SEISMIC PERFORMANCE CATEGORY: C
Uo FLOORS: - 1.32	ASSUMED ALLOWABLE SOIL PRESSURE: 3000 P.S.F.
BUILDING IS CONDITIONED	SETBACKS: GREATER THAN 10 FEET FROM COMMON OR ASSUMED PROPERTY LINE.
EXTERIOR WALL FIRE RATING: 0 Hr	

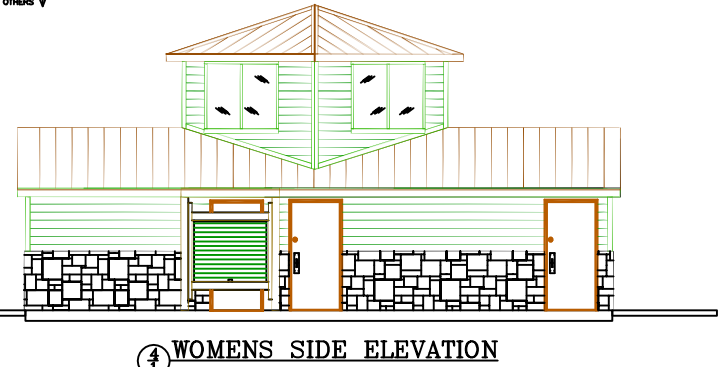

GENERAL NOTES:

WOOD (ALL WOOD TO BE #2 K.D., S.Y.P. OR BETTER)

A. WALL FRAMING: .25 ACQ PRESSURE TREATED, #2, KILN DRIED, NOMINAL 2x4 (Ø 16" O.C. MIN.) AND 2x8 (Ø 24" O.C. MIN.) SOUTHERN YELLOW PINE WITH 4x4 DOOR HEADERS AND BOTTOM PLATES.

B. ROOF FRAMING: #2, KILN DRIED, .25 ACQ PRESSURE TREATED, NOMINAL SOUTHERN YELLOW PINE, 2x8 RAFTERS AT NOMINAL 24" ON CENTER FASTENED WITH ACQ RATED FRAMING ANCHORS AND FASTENED WITH ACQ RATED GALVANIZED NAILS.

C. ROOF SHEATHING: 3/4" CDX PLYWOOD FIRST FLOOR AND 5/8" FLASHING SECOND FLOOR ROOF.

D. FASCIA & BASE: NOMINAL 5/4" X 6" ABTCO PRO-TRIM WITH TEXTURED WOOD FINISH.

THERMAL AND MOISTURE PROTECTION

A. ROOF: 24 GAUGE MINI BATTON BY METAL SALES COLOR BY OWNER.

B. ROOF FLASHING: 24 GAUGE METAL DRIP EDGE COLOR BY OWNER.

C. WALL INSULATION: SHALL HAVE KRAFT FACED R-13 BATT INSULATION IN ALL WALL FRAMING.

D. SOFFIT VENT: ONE LAYER OF GALVANIZED EXPANDED LATH WITH ONE LAYER OF GALVANIZED INSECT SCREEN OUTSIDE. SET IN RAFTER OPENINGS AT EACH BAY AND MECHANICALLY FASTENED TO WALL FRAMING AND ROOF DECKING. SEE DETAIL 6/8.

E. CHASE FLOOR SEALANT: CONCRETE FLOOR TO RECEIVE PROTECTIVE TYPE FLOOR TREATMENT. COLOR TO BE GREY.

F. RESTROOM FLOOR: ALTR0 SAFETY FLOORING WALKWAY 20 VM20907 BISCUIT, GRAND DESIGN, 2.0 MM (0.080 INCHES) OVERALL THICKNESS; CLASS 1 ASTM E 648 SLIP RESISTANCE > 60 ASTM D 2047. FLOORING SHALL BE GLUED DOWN USING A SOLVENT FREE, NON FLAMMABLE ADHESIVE. CHASE CHASE AND ENTRANCE FLOOR SHALL BE CONCRETE WITH A FINE BROOM FINISH AND SEALED GREY.

EXTERIOR FINISHES

A. WITH BUILDING WRAP VAPOR BARRIER OVER 1/2" THICK CDX PLYWOOD.

B. TRIM WORK: NOMINAL 5/4x ABTCO WOOD TEXTURED.

C. WALL FINISH: FACTORY PRIMED 5/16" x 4"x8" CERTAINTED CEDAR WOOD TEXTURED FIBER CEMENT FIBER 7.25" BEVELED LAP WITH 6" REVEAL.

HUNTER COMPANY
#10 HUNTER TRAIL
P.O. BOX 899
LAGRANGE, KY 40031
800-626-6530

SYMBOL: SUPPLIED BY MANUFACTURER AND INSTALLED BY OTHERS.
SYMBOL: SUPPLIED AND INSTALLED BY OTHERS.

SHEET TITLE	
ELEVATIONS AND DESIGN CRITERIA	
PROJECT NAME	
BASEBALL PARK BUILDING	
PROJECT LOCATION	
STANFORD, KY.	

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IMPORTANT
Note it is the responsibility of the user to verify that these plans meet or exceed all applicable codes and regulations. It is the user's responsibility to obtain all necessary permits and approvals from the local authorities.

DRAWN	CHECKED	APPROVED	DATE	SCALE
TKII	BG		10/12/06	1/8"=1' Ø 1"=10'

REVISIONS		
MARK	DESCRIPTION	DATE

FILE NAME	PROJECT ENGINEER	SHEET
HK-86		1
MODEL #		of 12
DWG4-2437-CON-STO-OBSERVATION		